
## Oregon State University

### PHARMACY GENERATOR

#### **VICINITY MAP**

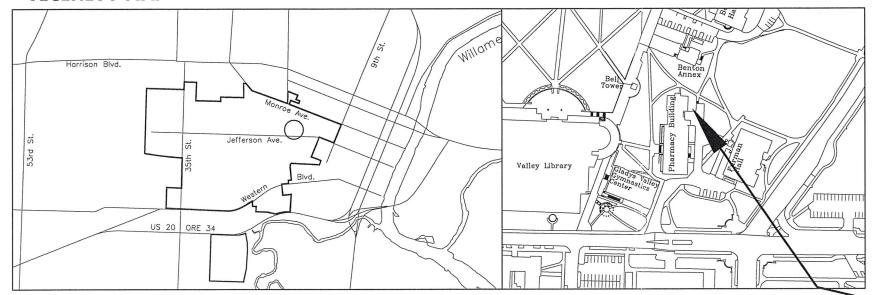

1. CONTRACTOR'S EQUIPMENT SHALL BE SIZED SO THAT ALL WORK DOES NOT CONTACT TREES, LIMBS, DRIPLINES, ETC.

4. ALL CONSTRUCTION FOR THIS PROJECT SHALL CONFORM TO THE REQUIREMENTS OF:

LOCATIONS AND DEPTHS OF EXISTING UTILITIES ARE APPROXIMATE. THE CONTRACTOR IS RESPONSIBLE FOR FIELD VERIFICATION OF EXISTING UTILITY LOCATIONS. FIELD

OREGON LAW REQUIRES THE CONTRACTOR TO FOLLOW RULES ADOPTED BY THE OREGON UTILITY LOCATE CENTER AS SET FORTH IN OAR 952-001-0010 THROUGH 952-001-0090. COPIES OF APPLICABLE RULES ARE ATTAINABLE BY CALLING THE CENTER AT (503) 232-1987. CALL 1-800-332-2344 FOR

7. ALL EXCAVATIONS SHALL COMPLY WITH ORS 757.541 TO 757.571 AND OSU

8. ALL WORK ZONE(S) SHALL BE DELINEATED AND ENCLOSED IN WITH SIX FOOT CHAIN LINK FENCE.

CONTRACTOR TO MINIMIZE CLOSURES OF LOADING DOCK AND ADJACENT BUILDING ENTRANCE. NOTIFY OAR 48 HOURS PRIOR TO WORK FOR

LOCATES, AND POTHOLING SHALL BE PERFORMED SUFFICIENTLY EARLY IN THE PROJECT SUCH THAT DESIGN ADJUSTMENTS, IF NECESSARY, CAN BE COMPLETED WITHOUT IMPACTING THE PROJECT SCHEDULE. THE CONTRACTOR SHALL NOTIFY THE ENGINEER IMMEDIATELY OF ANY DISCREPANCIES BETWEEN FIELD LOCATES AND THESE

(1), THE CITY OF CORVALLIS STANDARD CONSTRUCTION SPECIFICATIONS (2), OREGON DEPT OF TRANSPORTATION (ODOT), "OREGON STANDARD SPECIFICATIONS FOR CONSTRUCTION" (3), AND AS PROVIDED ON THESE PLANS AND SPECIFICATIONS (4). ANY CONFLICTS SHALL BE RESOLVED WITH THE MOST CONSERVATIVE SOLUTION TAKING PRECEDENCE. THE CONTRACTOR SHALL PROVIDE MEANS AND METHODS FOR TRAFFIC AND DEPETEDIAN CONTROL AT ALL TIMES.

CONTRACTOR TO DRIVE EQUIPMENT IN CONSTRUCTION ZONE ONLY AS NECESSARY TO PERFORM WORK, SIZE EQUIPMENT TO AVOID DAMAGE TO HARDSCAPE. VEHICULAR ACCESS TO SITE FROM THE SOUTH ONLY.

3. CONTRACTOR SHALL PROTECT ALL EXISTING STRUCTURES AND IMPROVEMENTS DURING CONSTRUCTION AND SHALL FULLY RESTORE ANY STRUCTURE AND/OR

IMPROVEMENT DAMAGED OR OTHERWISE MODIFIED DURING CONSTRUCTION.

GENERAL NOTES

AND PEDESTRIAN CONTROL AT ALL TIMES.

6. ATTENTION

DRAWING INDEX:

-C1.0COVER SHEET

EROSION CONTROL. TREE PROTECTION. SURVEY & DEMO -C1.1

SITE PLAN -C1.2

**DETAILS** -C1.3

LANDSCAPE PLAN -L1.0

PROJECT SITE

FROST DEPTH REQUIREMENT.

OSU AUTHORIZED REPRESENTATIVE (OAR): NATHAN PATTERSON PHONE (541) 737-6959 CELL (541) 231-7862 EMAIL NATHAN.PATTERSON@OREGONSTATE.EDU

PHONE (541) 510-3322

and the same

**DEVELOPMENT SERVICES** 





PLEASE SEE OFFIC 1809,5 POK

ENGINEER OF RECORD (EOR): MIKE BLAIR - ISE OREGON LLC

EMAIL MIKE. BLAIR @ISEOREGON. CONECEIVE

Infrastructure Solutions

Engineering, u.c

Civil & Environmental Engineering www.iseoregon.com P.O. Box 9 Corvallis, OR 97339 Cell: 541.510.3322

Email; mike.blair@iseoregon.com

OREGON STATE UNIVERSITY OSU PROJECT NUMBER: 1700-014 HARM, NERA

口

OREGON VXY 15, 199 CHAELS. BLAN

Expiration date: 12-31-15

JY/NP Drawn By: MSB Checked:

1700-014


2/2/2015

SHEET TITLE

COVER SHEET

Project #

**SCANNEI** 

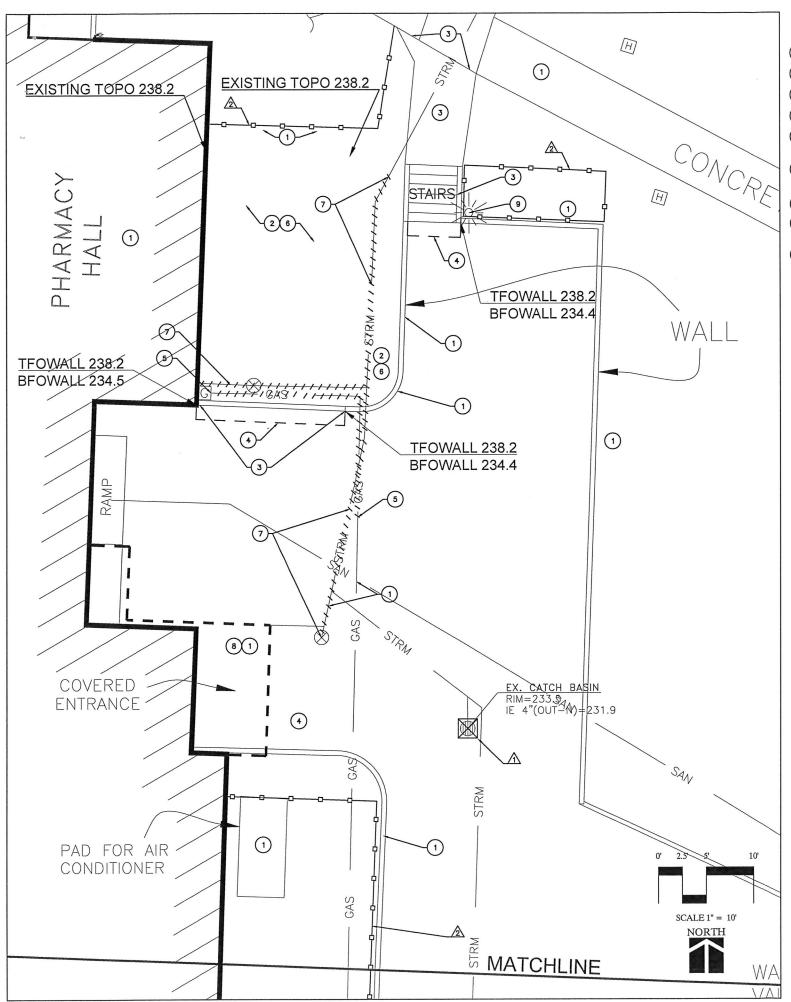


#### **CIVIL CONSTRUCTION NOTES**

- (1) PRESERVE AND PROTECT EXISTING IMPROVEMENT AND/OR VEGETATION.
- (2) CLEAR AND GRUB VEGETATION FOR SLAB, WALL, AND NEW STORM LINE CONSTRUCTION.
- 3 SAWCUT AND REMOVE CONCRETE WALL, FOOTING, STEPS, AND ASPHALT PATH FOR NEW CONFIGURATION. SHORE/BRACE WALLS TO REMAIN AS NEEDED UNTIL CONSTRUCTION COMPLETED.
- SAWCUT ASPHALT ADJACENT TO NEW SLAB AND WALL REPAIR A MINIMUM 18-INCH WIDTH, OR WIDER TO FACILITATE CONTRACTOR'S ASPHALT COMPACTION EQUIPMENT.
- 5 COORDINATE WITH NORTH-WEST NATURAL GAS COMPANY (NWN) FOR RELOCATION OF GAS METER AND LOWERING OF SERVICE CONNECTION. ALL NECESSARY EXCAVATION TO BE DONE BY CONTRACTOR TO FACILITATE NWN CREWS. NWN WILL POTHOLE GASLINE UPSTREAM OF METER AND PLACE A STOP IN LINE. CONTRACTOR SHALL COORDINATE WORK TO MINIMIZE GAS SHUT OFF TO BUILDING.
- 6 EXCAVATE FOR GENERATOR SLAB, UTILITIES, AND RETAINING WALLS. DISPOSE OF SOIL OFFSITE UNLESS SOIL IS APPROVED BY OAR TO BE SALVAGED AND DELIVERED TO OSU BONEYARD (35TH & WASHINGTON). COVER AND SECURE ANY SALVAGED SOIL, PROVIDE APPROVED CLEAN PLANTBED SOIL TO BACKFILL NEW PLANTER AREAS AFTER CONCRETE WALL CONSTRUCTION.
- B MAINTAIN SAFE ACCESS TO BUILDING USING FENCING TO DELINEATE PATHWAY. CLOSURE OF BUILDING ENTRANCE MUST BE COORDINATED 48 HOURS IN ADVANCE OF APPROVED CLOSER, COORDINATE WITH OAR. PROVIDE SIGNAGE DIRECTING TO NEXT AVAILABLE EXIT. EMERGENCY EXIT FUNCTION MUST REMAIN DO NOT BLOCK DOORWAY.
- COORDINATE WITH OSU ELECTRICAL SHOP TO SHUT OFF POWER TO LIGHT, REMOVE LIGHT AND DELIVER TO DESIGNATED LOCATION ON CAMPUS. REMOVE LIGHT FOOTING.

#### **EROSION CONTROL & TREE PROTECTION NOTES**

- 1 INSTALL EROSION CONTROL MEASURES PER DETAIL 2 SHEET C1.3
- ⚠ INSTALL 6 FOOT CHAIN-LINK TREE PROTECTION FENCING. LABEL AS "TREE PROTECTION AREA NO ENTRY OR STORAGE OF MATERIALS"

#### SITE PROTECTION AT BUILDING PENETRATION

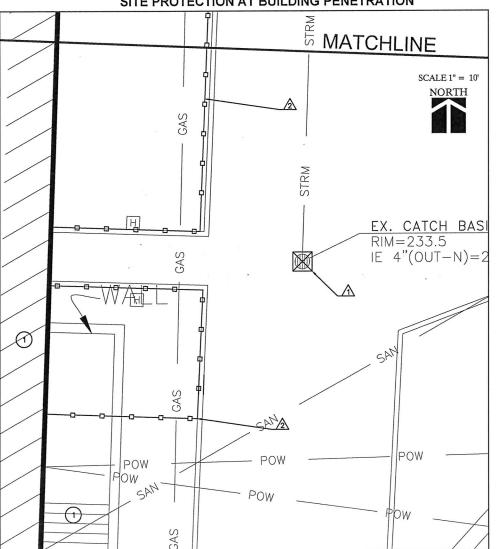



Infrastructure Solutions

Engineering, uc

www.iseoregon.com P.O. Box 9 Corvallis, OR 97339 Cell: 541.510.3322

Email: mike.blair@iseoregon.com

OREGON STATE UNIVERSITY OSU PROJECT NUMBER: 1700-014 PHARMACY GENERATOR

OREGON Drawn By: IY/NP **MSB** 

2/2/2015


Fehrelden date: 1700-014 Project #:

Date:

SHEET TITLE

SITE MNGMT **SURVEY AND DEMO** 

SHEET#

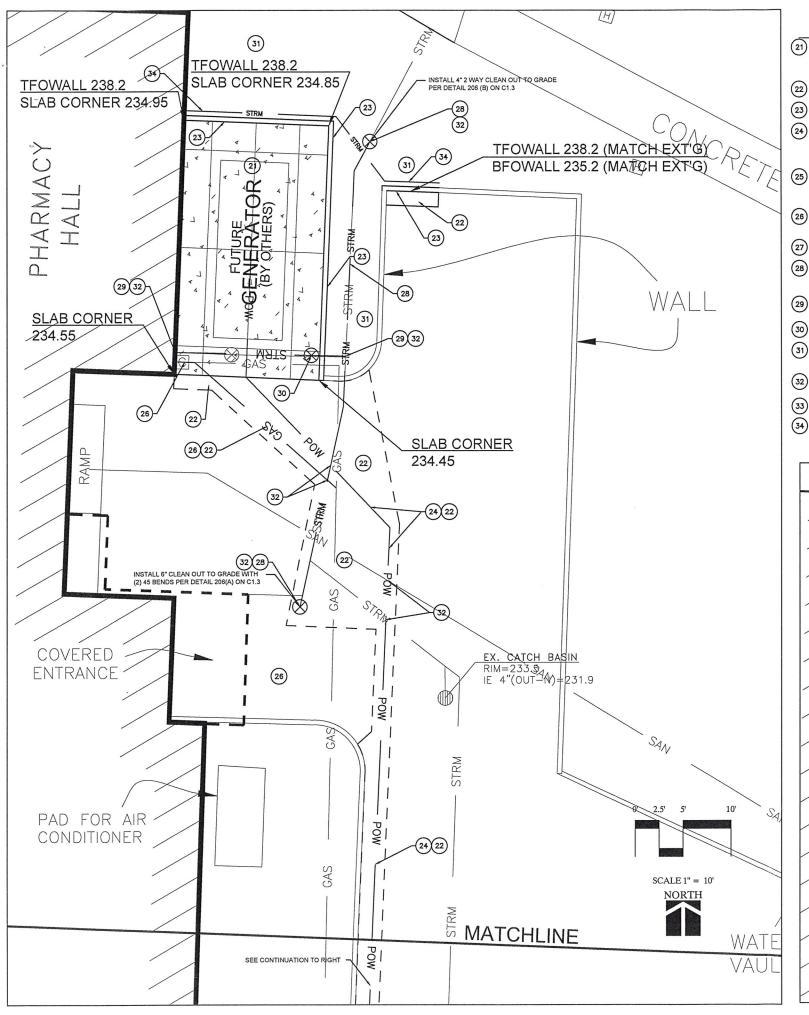

Thickeil construction notes

21 CONSTRUCT 15'-2" X 26'-6" X 18" THICK CONCRETE SLAB OVER 6" OF 3"-0" BASE ROCK. PLACE 16 REBAR 12" ON CENTER, EACH WAY. PLACE REBAR 2 INCHES FROM BOTTOM OF POUR AND EDGES. CONSTRUCT JOINTS PER DETAIL 1, SHEET C1.3 PRIOR TO FORMING, COORDINATE ELECTRICAL CONDUIT LOCATION IN SLAB WITH OAR AND OSU ELECTRICAL SHOP FOR STUB UP. CONDUITS TO BE PLACED BY

22) PLACE 5 INCHES OF ASPHALT IN TWO LIFTS OVER MINIMUM 12 INCHES OF \$"-0" BASEROCK PER CITY OF CORVALLIS STANDARD CONSTRUCTION SPECIFICATIONS.

CONSTRUCT RETAINING WALL AND FOOTING PER DETAIL 3, SHEET C1.3. DOWEL INTO EXISTING RETAINING WALL WITH \$4 REBAR, 12 INCHES ON CENTER. PLACE 1-1/2" GALVANIZED PIPING FOR WEEP HOLES THROUGH NEW WALL ON 4 FOOT CENTERS, SIMILAR TO EXISTING WALL

24) STREET CUT AND PROVIDE TRENCH FOR (3) 3 INCH PVC CONDUITS AND (3) 1 INCH PVC CONDUIT FOR ELECTRICAL PROVIDE 36 INCHES OF COVER OVER CONDUITS. COORDINATE WITH OSU ELECTRICAL SHOP. OSU PERSONNEL TO PROVIDE AND INSTALL ELECTRICAL CONDUIT. PROVIDE 4 INCHES OF SAND FOR BEDDING AND 8 INCHES OF SAND ABOVE CONDUIT. PLACE DETECTABLE UNDERGROUND WARNING TAPE ON TOP OF SAND LAYER, SEE CITY STANDARD DETAILS 110 & 201 PIPE TRENCH FOR STREET CUT WORK. OSU ELECTRICAL SHOP TO

(25) COORDINATE WITH OAR AND OSU ELECTRICAL FOR LOCATION WHERE ELECTRICAL CONDUITS WILL ENTER BUILDING. TRENCH FROM STREET (3-FEET COVER OVER CONDUITS) TO BUILDING (30-INCHES COVER). EXCAVATE AT BUILDING TO ACCOMODATE ACCESS FOR CONCRETE CORING (BY OTHERS) INTO BUILDING. CONTRACTOR TO PROVIDE WATER TIGHT SEAL AROUND CONDUIT PENETRATIONS INTO BUILDING. OSU ELECTRICAL SHOP TO PULL WIRES THROUGH CONDUITS.

COORDINATE WITH NWN FOR RELOCATING 1-INCH GAS LINE AND RELOCATING GAS METER. CONTRACTOR TO PROVIDE TRENCHING AND BACKFILL MINIMUM COVER OVER GAS LINE TO BE 18-INCHES. NEW GAS LINE TO CONNECT TO EXISTING, ADJACENT TO ELECTRICAL TRENCH. SEE CITY STANDARD DETAILS 110 AND 201 FOR TRENCH AND STREET CUT WORK.

(27) PROTECT WALL OF PHARMACY BUILDING DURING CONCRETE WORK. CLEAN WALL AT END OF PROJECT.

CONSTRUCT 50LF NEW 8-INCH ASTM D3034 SDR35 STORM LINE PER CITY OF CORVALLIS STANDARD CONSTRUCTION SPECIFICATIONS, RELOCATE AS SHOWN ON DRAWING, REPLACE EXISTING CLEAN OUT AT SOUTH END WITH NEW, RECONNECT ALL LATERALS. REMOVE AND CAP ABANDONED UTILITIES AS ENCOUNTERED DURING EXCAVATION, CONSTRUCT CLEAN OUT AT NORTH END OF NEW STORM LINE. CONSTRUCT CLEAN OUTS PER CITY DETAIL 206, SHEET C1.3, INSTALL TRACER WIRE WITH 4-INCH PIPE.

(29) CONSTRUCT NEW 4-INCH DROP AT EXTERIOR OF BUILDING TO BELOW SLAB BASEROCK PER CITY OF CORVALLIS STANDARD CONSTRUCTION SPECIFICATIONS. CONSTRUCT 18 LF OF NEW 4-INCH ASTM D3034 SDR35 STORM LINE AT MINIMUM 0.5% SLOPE. PLACE TRACER WIRE OVER NEW PIPING, ACCESSIBLE FROM CLEAN OUT COVER.

(30) INSTALL TWO WAY CLEAN OUT PER CITY DETAIL 206, SHEET C1.3. INSTALL APPROVED CLEAN OUT COVER INTO GENERATOR SLAB.

(31) INSTALL SOIL IN LANDSCAPE AREAS BEHIND RETAINING WALL. COORDINATE WITH OAR IF SALVAGED SOIL IS TO BE RE-USED. OTHERWISE, PLACE NEW LOAM TO MATCH EXISTING GRADES AND TOP OF WALLS AT MAXIMUM 3H:1V GRADE.

32) PRIOR TO BEGINNING CONSTRUCTION, POTHOLE AND FIELD VERIFY LOCATION AND DEPTHS OF EXISTING UTILITIES. NOTIFY AND COORDINATE WITH OAR TO AVOID CONFLICTS.

(33) REMOVE AND REPLACE 2 LF STRAIGHT CURB PER CITY STD DETAIL 103, SHEET C1.3.

CONSTRUCT 30 LF OF NEW 3-INCH PVC ASTM2729 PERFORATED PIPE ALONG BACK OF NEW WALL. PLACE BOTTOM OF PIPE TRENCH AT ELEVATION OF LOWEST WEEP HOLES IN WALLS. SEE DETAIL 3 SHEET C1.3

SITE PLAN AT BUILDING PENETRATION 5 MATCHLINE SCALE 1" = 10' NORTH S H EX. CATCH BAS RIM=233.5 IE 4"(OUT-N)=PO 24 (22) SAL SAN POW WOF SAM POW

# UNIVERSITY

nfrastructure Solutions

Engineering, uc

Civil & Environmental Engineering www.iseoregon.com P.O. Box 9 Corvallis, OR 97339 Cell: 541.510.3322

Email: mike.blair@iseoregon.com

UNIVERSITY OREGON STATE UNIVERSIT OSU PROJECT NUMBER: 1700-014 PHARMAC PH. GEN



Expiration date: JY/NP

Drawn By:

Checked:

Project #:

Date:


1700-014 2/2/2015

**MSB** 

SHEET TITLE

SITE PLAN

SHEET#

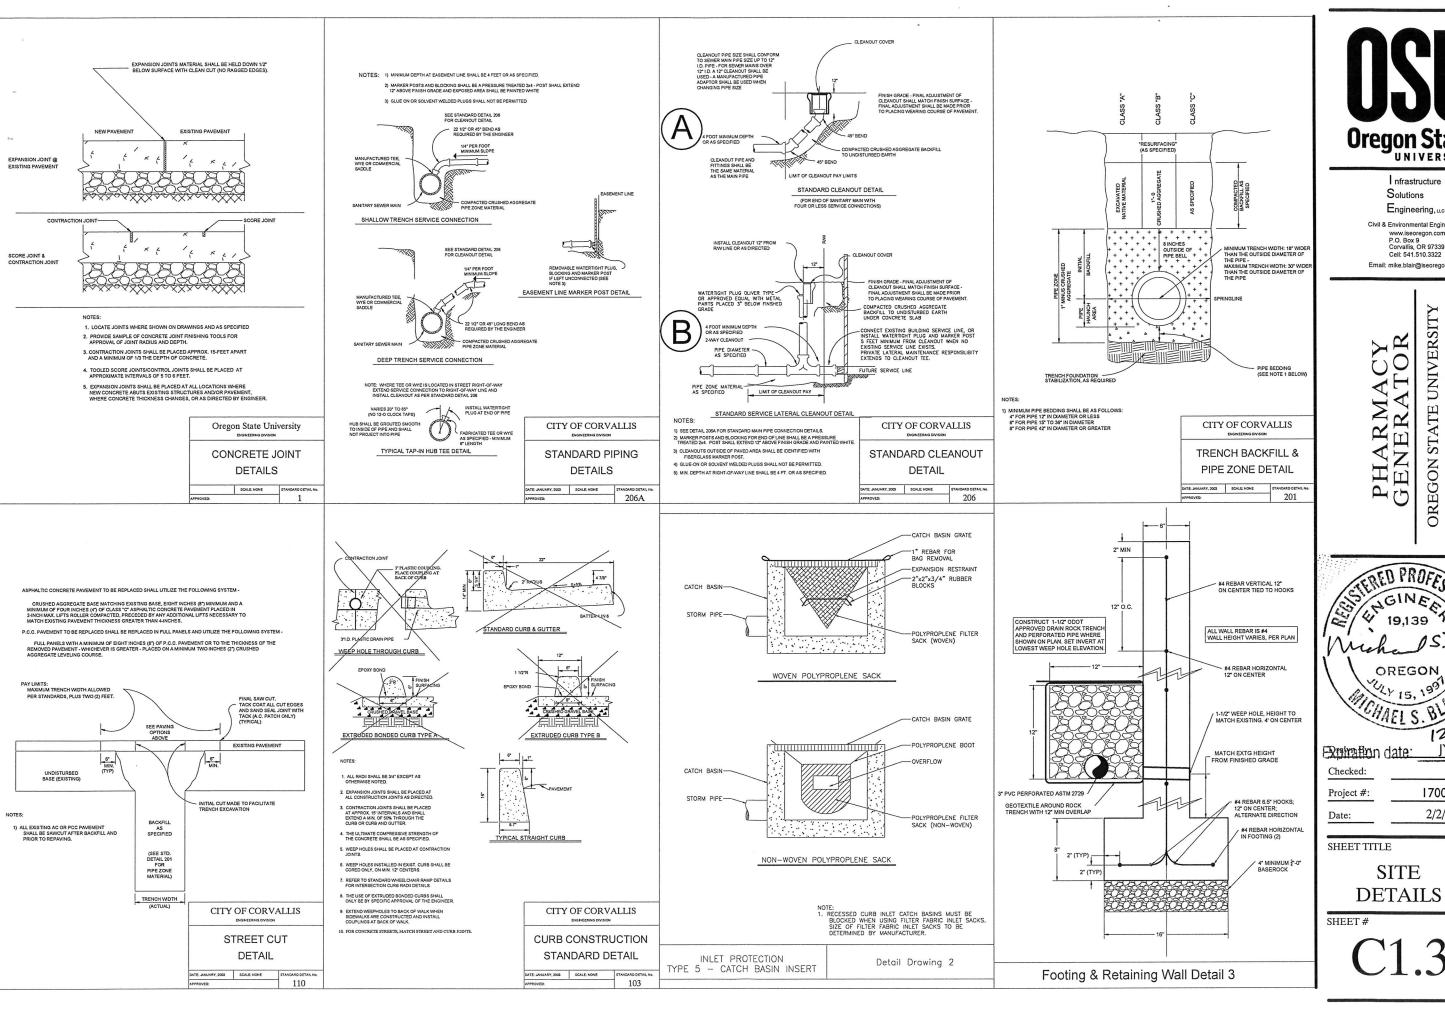

UNIVERSITY

nfrastructure Solutions

Engineering, uc

Civil & Environmental Engineering www.iseoregon.com P.O. Box 9 Corvallis, OR 97339 Cell: 541.510.3322

Email: mike.blair@iseoregon.com

OREGON STATE UNIVERSITY OSU PROJECT NUMBER: 1700-014 CY 4

PHAR GENEI OREGON.


CHAEL S. BLAIR 12.31.15 JY/NP Exgination date: MSB

2/2/2015

1700-014


SHEET TITLE

SITE **DETAILS** 

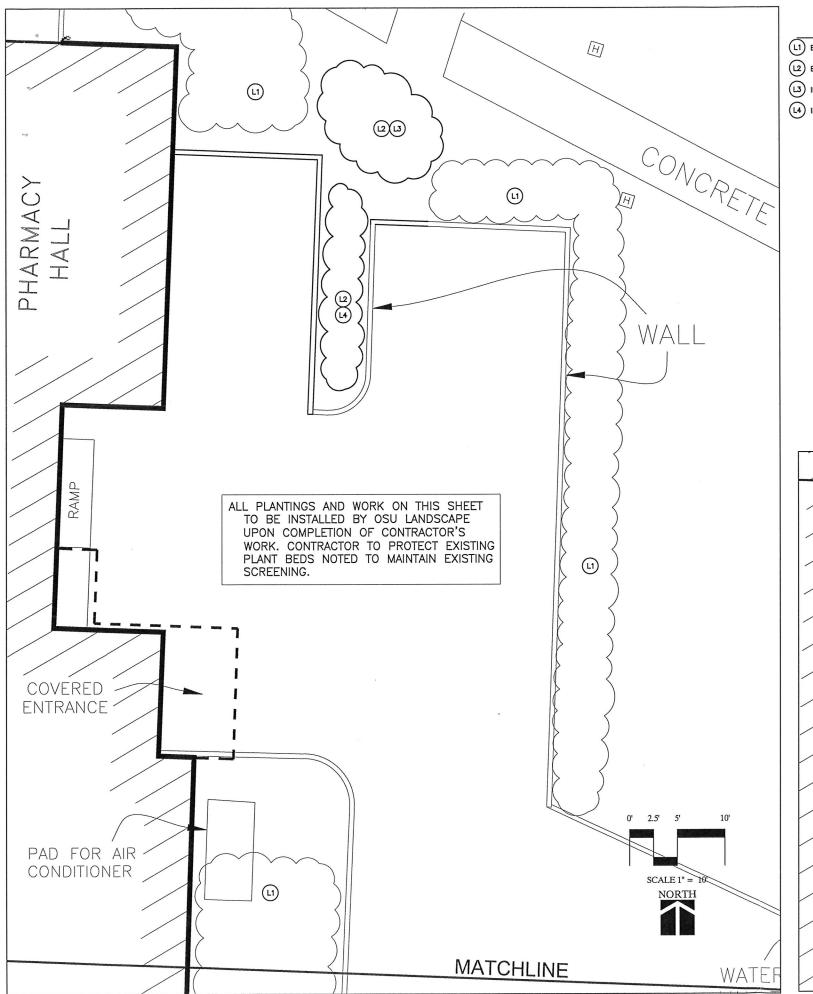

#### LANDSCAPE CONSTRUCTION NOTES

- (L1) EXISTING PLANTINGS TO REMAIN / RESTORED TO EXISTING CONDITIONS TO PROVIDE MAINTAIN EXISTING SCREENING
- (12) ESTABLISH NEW PLANTINGS FOR THE PURPOSE OF SCREENING PER SUBMITTED ARBORIST LETTER (OSU LANDSCAPE SUPERVISOR)
- (L3) INSTALL 8'-10' TALL (AT MATURITY) PLANTINGS TO PROVIDE SCREENING
- (L4) INSTALL 6'-8' TALL (AT MATURITY) PLANTINGS TO PROVIDE SCREENING

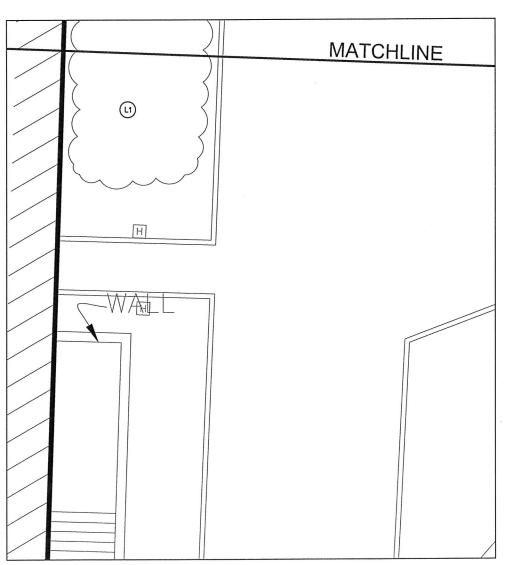



I nfrastructure Solutions

Engineering, uc

Civil & Environmental Engineering www.iseoregon.com P.O. Box 9 Corvallis, OR 97339 Cell: 541.510.3322

Email; mike.blair@iseoregon.com

OREGON STATE UNIVERSITY OSU PROJECT NUMBER: 1700-014 PHARMACY GENERATOR



Checked: Project #:

1700-014 2/2/2015 Date:

MSB

SHEET TITLE

LANDSCAPE **PLAN** 

SHEET#